

WEST VIRGINIA STATE UNIVERSITY KANAWHA COUNTY, WEST VIRGINIA ROOF RENOVATIONS – JONES HALL ADDENDUM #2 THRASHER PROJECT #T60-11251 SOLICITATION NUMBER: ARFQ WSC2500000004 September 11, 2024

TO WHOM IT MAY CONCERN:

A MANDATORY Pre-Bid Conference was held on Tuesday, August 20, 2024, on the above-referenced project. The following are clarifications and responses to questions posed by contractors for the above reference project.

- A. <u>GENERAL</u>
 - 1 None
- B. <u>SPECIFICATIONS</u>
 - 1. None
- C. DRAWINGS
 - 1. AD1.01 and A1.01
- D. QUESTIONS AND RESPONSES

OUESTION

1. Are we to replace all metal edge and put back same as there is now

RESPONSE

Yes, see revised note on drawing AD1.01 attached to this addendum.

E. CLARIFICATIONS

1. None

If you have any questions or comments, please feel free to contact me at your earliest convenience. As a reminder, bids will be received until 2:30 p.m. on Tuesday, September 17, 2024. Good luck to everyone and thank you for your interest in the project.

Sincerely,

THE THRASHER GROUP, INC.

AMANDA CHEUVRONT, AIA, NCARB

Project Manager

113' - 3"

GENERAL NOTES:

- 1. THE SCOPE OF THE WORK IS GENERALLY LIMITED TO THE AREAS SHOWN ON THESE PLANS. WORK NECESSARY TO RUN ELECTRICAL SERVICE TO EXISTING PANELS OR EXTEND OR REROUTE OTHER UTILITY LINES IS ALSO INCLUDED.
- 2. CONTRACTOR SHALL SCHEDULE NOISY, NOXIOUS, OR DISRUPTIVE ACTIVITIES WITH THE OWNER.
- 3. THE OTHER AREAS OF THE BUILDING WILL REMAIN IN OPERATION FOR THE DURATION OF THE CONSTRUCTION CONTRACT. COOPERATION AND CONSIDERATION BY THE CONTRACTOR AND WORKMEN ON SITE WILL BE REQUIRED. THE CONTRACTOR SHALL SCHEDULE AND COORDINATE WORK
- 6. REMOVE TRASH AND OTHER DEBRIS FROM ALL BUILDINGS AND FACILITY
- EXISTING CONDITIONS PRIOR TO COMMENCEMENT OF ANY ON SITE ACTIVITIES. EXISTING EQUIPMENT, ROOF PENETRATIONS, PIPING ETC. SHOWN IS BASED UPON EXISTING DRAWINGS AND FIELD SURVEYS. CONTRACTOR SHALL FIELD VERIFY ALL CONDITIONS AFFECTED AND NOTIFY THE ARCHITECT IF CONDITIONS ARE NOT AS
- 9. INSTALL ELEVATED PIPE BRACKETS, SUPPORTS, AND PADS TO MEET ROOFING MFR STANDARDS FOR COMPLIANCE WITH ROOF WARRANTY REQUIREMENTS.
- NORMAL SERVICE AREAS.
- MANUFACTURER'S WARRANTY REQUIREMENTS AND TO ASSURE WATERTIGHTNESS.
- VALLEYS LEADING TO ROOF DRAINS WITH NO PONDING.
- TAPERED INSULATION AS REQUIRED TO DIRECT STORMWATER TOWARD ROOF DRAINS AND VALLEYS LEADING TO ROOF DRAINS.
- TOWARD ROOF DRAINS AND VALLEYS LEADING TO ROOF DRAINS.
- 16. USE TAPERED INSULATION TO CREATE CRICKETS AT ROOF PENETRATIONS,
- 17. VALLEYS SHALL BE DEAD FLAT BETWEEN ROOF DRAINS SO THAT NO PONDING

EXISTING LIGHT FIXTURE TO REMAIN. EXISTING CONDUIT TO REMAIN.

REMOVE AND REPLACE METAL COPING/FASCIA.

600 WHITE OAKS BLVD.

P.O. BOX 940

P (304) 624-4108

F (304) 624-7831

www.thethrashergroup.com

THE INFORMATION CONTAINED HEREIN IS

THE SOLE PROPERTY OF THE THRASHER

GROUP, INC. REPRODUCTION OF THESE

DOCUMENTS IN WHOLE, OR IN PART FOR ANY REASON WITHOUT PRIOR WRITTEN

PERMISSION IS STRICTLY PROHIBITED.

COPYRIGHT © 2024

THE THRASHER GROUP, INC.

BRIDGEPORT, WV 26330

ES JON

ROOF

DRAWN: ALB DATE: 08/08/24

CHECKED: AJC DATE: 08/08/24 PROJECT No.


JONES HALL ROOF PLAN - DEMOLITION

T60-11251

AD1.01

JONES HALL ROOF PLAN - DEMOLITION AD1.01/ 1" = 10'-0"

ACTIVITIES WITH THE OWNER. 4. ASBESTOS ABATEMENT IS NOT ANTICIPATED FOR THIS PROJECT. 5. PROTECT ALL ITEMS TO REMAIN - PATCH AND REPAIR ALL ITEMS TO REMAIN IF DAMAGED. VOIDS OR DAMAGES TO EXISTING STRUCTURES, FINISHES, AND/OR SITE/SITE ITEMS TO REMAIN MUST BE REPAIRED TO MATCH OR EXCEED EXISTING CONSTRUCTION. GROUNDS UNLESS OTHERWISE NOTED. 7. CONTRACTOR SHALL DISPOSE OF ALL DEMOLISHED MATERIAL IN ACCORDANCE WITH ALL APPLICABLE LOCAL AND STATE LAW. 8. DIMENSIONS ARE FOR REFERENCE ONLY. CONTRACTOR TO FIELD VERIFY INDICATED OR NOTED IN THESE DOCUMENTS. 10. INSTALL RUBBER WALKING PADS FOR ACCESS TO ALL HVAC EQUIPMENT AND 11. FLASH TO ALL EXISTING ROOFTOP EQUIPMENT AND SEAL ALL PENETRATIONS PER 12. FINISHED ROOFS SHALL PROVIDE POSITIVE DRAINAGE TO ROOF DRAINS AND 13. ON SLOPING ROOF DECKS PROVIDE A COMBINATION OF FLAT INSULATION AND 14. AT FLAT ROOF DECKS PROVIDE TAPERED INSULATION TO DIRECT STORMWATER 15. USE TAPERED INSULATION TO DIRECT STORMWATER AWAY FROM WALLS AND PARAPET WALLS AND TO A VALLEY A MINIMUM OF 4'-0" FROM WALL. CHIMNEYS, ROOF CURBS, ETC. **DEMOLITION NOTES** DESCRIPTION REMOVE EXISTING BALLAST, MEMBRANE ROOFING AND RIGID INSULATION. NOT USED. D3 EXISTING ROOF MOUNTED EQUIPMENT TO REMAIN. PROVIDE NEW FLASHING TO RUN UP AND UNDER EXISTING MECHANICAL APRON FLASHING. SEAL ALL. EXISTING PIPE PENETRATION TO REMAIN. REMOVE EXISTING COUNTER FLASHING AND EXISTING MEMBRANE ROOFING. PREPARE COUNTER FLASHING FOR NEW FLASHING. PREPARE OF NEW EPDM ROOFING MEMBRANE. EXISTING ROOF HATCH TO REMAIN. PROVIDE NEW FLASHING TO RUN UP AND UNDER EXISTING APRON FLASHING. SEAL ALL. EXISTING OVERFLOW SCUPPERS TO REMAIN.

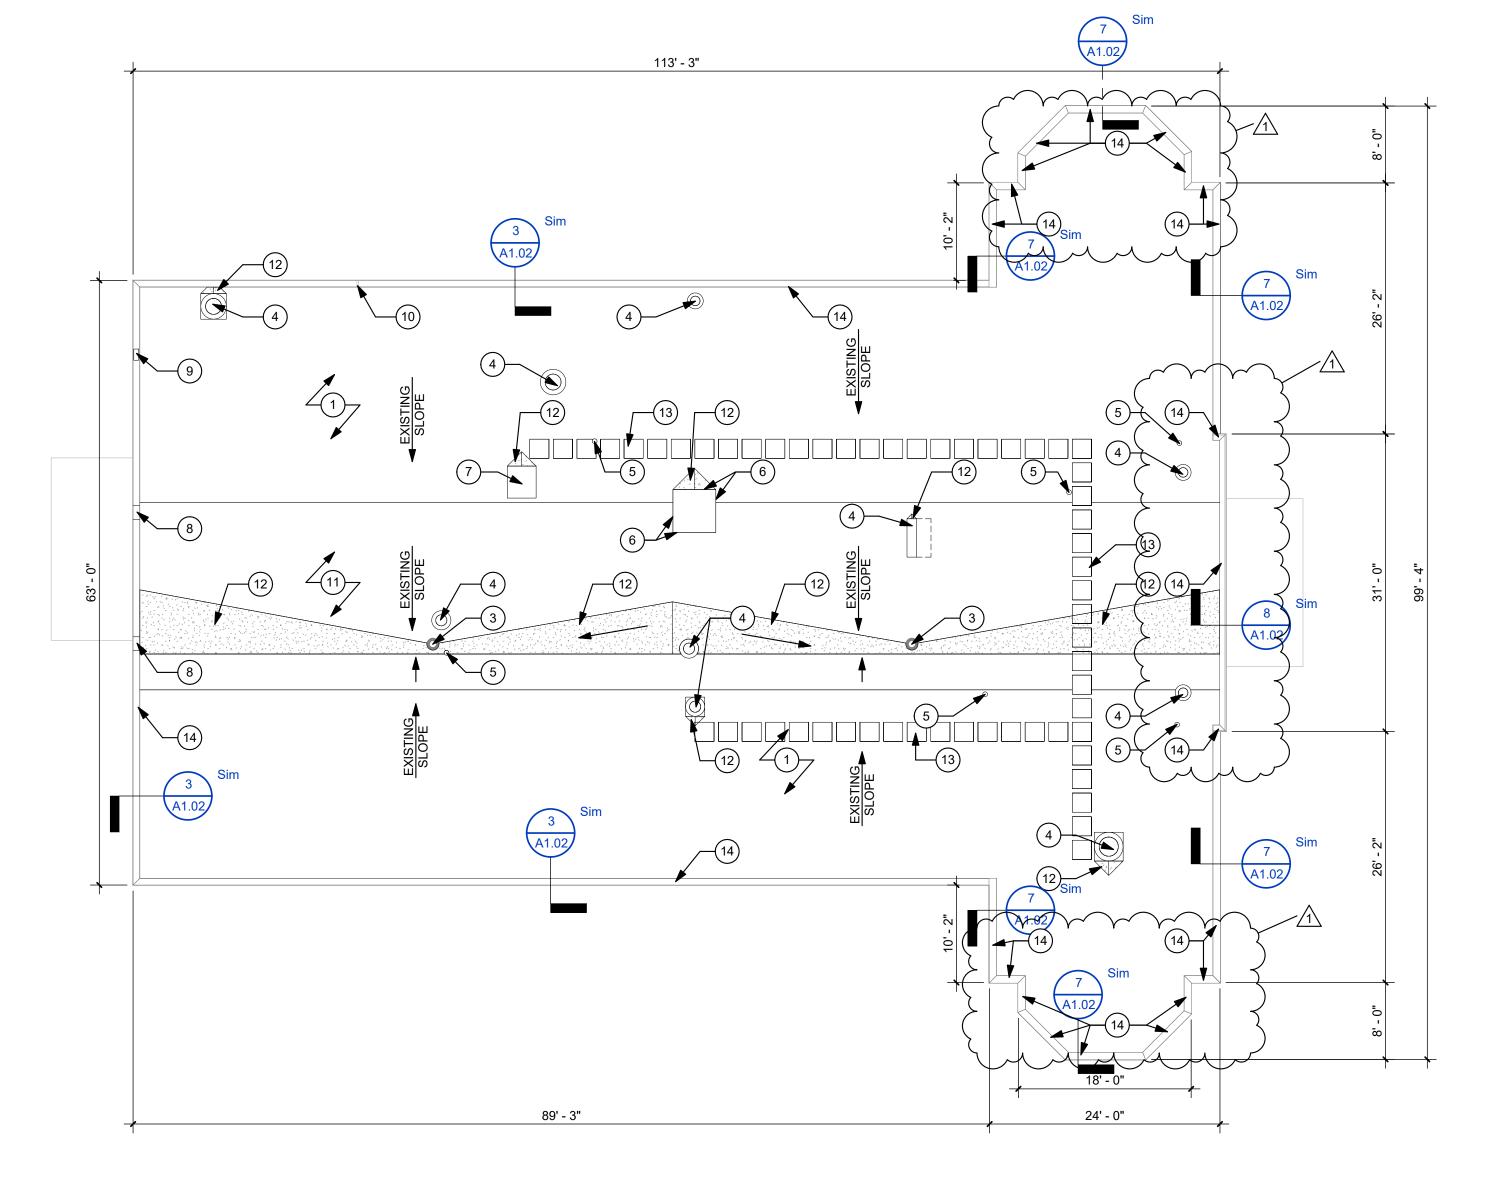

GENERAL NOTES:

- 1. THE SCOPE OF THE WORK IS GENERALLY LIMITED TO THE AREAS SHOWN ON THESE PLANS. WORK NECESSARY TO RUN ELECTRICAL SERVICE TO EXISTING PANELS OR EXTEND OR REROUTE OTHER UTILITY LINES IS ALSO INCLUDED.
- 2. CONTRACTOR SHALL SCHEDULE NOISY, NOXIOUS, OR DISRUPTIVE ACTIVITIES WITH THE OWNER.
- 3. THE OTHER AREAS OF THE BUILDING WILL REMAIN IN OPERATION FOR THE DURATION OF THE CONSTRUCTION CONTRACT. COOPERATION AND CONSIDERATION BY THE CONTRACTOR AND WORKMEN ON SITE WILL BE REQUIRED. THE CONTRACTOR SHALL SCHEDULE AND COORDINATE WORK ACTIVITIES WITH THE OWNER.
- DAMAGED. VOIDS OR DAMAGES TO EXISTING STRUCTURES, FINISHES, AND/OR SITE/SITE ITEMS TO REMAIN MUST BE REPAIRED TO MATCH OR EXCEED EXISTING

4. ASBESTOS ABATEMENT IS NOT ANTICIPATED FOR THIS PROJECT.

6. REMOVE TRASH AND OTHER DEBRIS FROM ALL BUILDINGS AND FACILITY GROUNDS UNLESS OTHERWISE NOTED.

5. PROTECT ALL ITEMS TO REMAIN - PATCH AND REPAIR ALL ITEMS TO REMAIN IF

- 7. CONTRACTOR SHALL DISPOSE OF ALL DEMOLISHED MATERIAL IN ACCORDANCE WITH ALL APPLICABLE LOCAL AND STATE LAW.
- 8. DIMENSIONS ARE FOR REFERENCE ONLY. CONTRACTOR TO FIELD VERIFY EXISTING CONDITIONS PRIOR TO COMMENCEMENT OF ANY ON SITE ACTIVITIES. EXISTING EQUIPMENT, ROOF PENETRATIONS, PIPING ETC. SHOWN IS BASED UPON EXISTING DRAWINGS AND FIELD SURVEYS. CONTRACTOR SHALL FIELD VERIFY ALI CONDITIONS AFFECTED AND NOTIFY THE ARCHITECT IF CONDITIONS ARE NOT AS INDICATED OR NOTED IN THESE DOCUMENTS.
- 9. INSTALL ELEVATED PIPE BRACKETS, SUPPORTS, AND PADS TO MEET ROOFING MFR STANDARDS FOR COMPLIANCE WITH ROOF WARRANTY REQUIREMENTS. 10. INSTALL RUBBER WALKING PADS FOR ACCESS TO ALL HVAC EQUIPMENT AND
- NORMAL SERVICE AREAS. 11. FLASH TO ALL EXISTING ROOFTOP EQUIPMENT AND SEAL ALL PENETRATIONS PER
- MANUFACTURER'S WARRANTY REQUIREMENTS AND TO ASSURE WATERTIGHTNESS. 12. FINISHED ROOFS SHALL PROVIDE POSITIVE DRAINAGE TO ROOF DRAINS AND
- VALLEYS LEADING TO ROOF DRAINS WITH NO PONDING. 13. ON SLOPING ROOF DECKS PROVIDE A COMBINATION OF FLAT INSULATION AND TAPERED INSULATION AS REQUIRED TO DIRECT STORMWATER TOWARD ROOF DRAINS AND VALLEYS LEADING TO ROOF DRAINS.
- 14. AT FLAT ROOF DECKS PROVIDE TAPERED INSULATION TO DIRECT STORMWATER TOWARD ROOF DRAINS AND VALLEYS LEADING TO ROOF DRAINS.

DESCRIPTION

- 15. USE TAPERED INSULATION TO DIRECT STORMWATER AWAY FROM WALLS AND PARAPET WALLS AND TO A VALLEY A MINIMUM OF 4'-0" FROM WALL.
- 16. USE TAPERED INSULATION TO CREATE CRICKETS AT ROOF PENETRATIONS, CHIMNEYS, ROOF CURBS, ETC.
- 17. VALLEYS SHALL BE DEAD FLAT BETWEEN ROOF DRAINS SO THAT NO PONDING

CONSTRUCTION NOTES

REQUIRED.

ROOF DRAIN OPERATIONAL.

FLASHING. SEAL ALL AROUND.

NEW TAPERED INSULATION CRICKET.

PROVIDE NEW WALKWAY PADS. PROVIDE NEW METAL COPING/FASCIA.

SEAL/FLASH EXISTING PIPE PENETRATIONS.

AND UNDER EXISTING APRON FLASHING. SEAL ALL.

RELINE ALL OVERFLOW SCUPPERS W/ MEMBRANE FLASHING. EXISTING LIGHT FIXTURE TO REMAIN. SEAL ALL AROUND. EXISTING CONDUIT TO REMAIN, SEAL ALL AROUND.

PROVIDE NEW EPDM ROOF ASSEMBLY. REPLACE CONCRETE DECK AS

600 WHITE OAKS BLVD. P.O. BOX 940 BRIDGEPORT, WV 26330

> P (304) 624-4108 F (304) 624-7831

THE INFORMATION CONTAINED HEREIN IS THE SOLE PROPERTY OF THE THRASHER

www.thethrashergroup.com

GROUP, INC. REPRODUCTION OF THESE DOCUMENTS IN WHOLE, OR IN PART FOR ANY REASON WITHOUT PRIOR WRITTEN PERMISSION IS STRICTLY PROHIBITED. COPYRIGHT © 2024 THE THRASHER GROUP, INC.

PROVIDE NEW EPDM ROOF ASSEMBLY. REPLACE WOOD DECK AS PREQUIRED. EXISTING ROOF DRAIN TO REMAIN REPLACE ROOF DRAIN AND STRAINER COVER AS REQUIRED. SEAL ALL AROUND DRAIN. VERIFY AND MAKE EXISTING ROOF MOUNTED EQUIPMENT TO REMAIN. PROVIDE NEW FLASHING TO RUN UP AND UNDER EXISTING MECHANICAL APRON EXISTING COUNTER FLASHING TO REMAIN. PROVIDE NEW EPDM ROOFING ENTIRE LENGTH OF EXISTING WALL. NEW FLASHING TO RUN UP 4 AND UNDER EXISTING COUNTER FLASHING. SEAL ALL AROUND. EXISTING ROOF HATCH TO REMAIN. PROVIDE NEW FLASHING TO RUN UF

NOC

ROOF

WVSU DRAWN: ALB DATE: 08/08/24 CHECKED: AJC DATE: 08/08/24

T60-11251

JONES HALL ROOF PLAN - PROPOSED

PROJECT No.

A1.01